PROPERTY OWNERS WITHIN 200 FEET

Gloucester County - Office of Taxation
Certified Adjoining Property List

This table is a listing of adjoining properties within 200 feet of the subject property.

Prepared by: Craig Black, CTA & Blue

Highlighted feature(s)

| Solyion Treespary (U | Mania/quitry | Block | Let | Qualify | U/U | Tection | Querry Rosse | Q

at of adjoining feature(s) that intersect 200 foot buffer from Subject Property.

List of adjoining feature(s)

Municipality	Mack	let	Qualifics	UID	Location	Owner Name	Owner	Owner Cor.	Additional Lets
Monroe Township	14301	1		0811- 143010000- 000010000- 00000	1531 N TUCKAHOE RD	CROSS KEYS ARPORT	PO BOX 1649	WILDWOOD, NJ 08260	
Monroe Township	14301	3		0811- 143010000- 000030000- 00000	1509 N TUCKAHOL RD	LEWIS PROPERTIES LATED LANGUTY CO	139 W TOMLIN STATION RD	MICKLETON, NJ 08056	
Morane Township	14301	•	QPARM	0813- 143010000- 000040000- QPARM	1531 N TUCKAHOE RD	LORINGING	749 MULLICA RD	MULLICA HILL NJ 08082	
Mancue Township	14301	4.01		0811- 143010000- 000040001- 00000	603 ARPORT DR	QEI	I'O BOX BOS	WILLIAMSTOWN, NJ 00094	
Morece Township	14301	4.02		0811- 143010000- 000040002- 00000	ADRPORT DR	RUNWAY PROPERTIES, LLC	402 AIRPORT DR	WILLIAMSTOWN, NJ 08094	
Monrue Township	14301	4.03		0811- 143010000-	4G1 AIRPORT	LEWIS PROPERTIES	139 W TOMLIN	MICKLETON, NJ	euronelli (1805

Municipaldy	Block	fut	Qualifier	UID	Louisin	Owner Name	thorner Street	Owner Cu	Additional Late
Monroe Township	15301	4.04		0811- 143010000- 000040004- 00000		LEWIS PROPERTIES LLC	139 W TOMLIN STATION ED	MICKLETON, NT	
Monroe Township	14301	5		0511- 143010000- 000050000- 00000	1499 N TUCKAHOR RD	HARGROVE, WILLIAM	1507 STATE ST	CAMDEN, NJ 68105	4
Monroe Township	14501	13		0811- 145010000- 000130000- 00000	1530 N TUCKAHOE KO	RUMWAY PROPERTIES LLC	1535 TUCKAHOE RDN	WILLIAMSTOWN,	Š
Manroe Township	14501	14		0611- 145210000- 000140000- 00000	N TUCKAHOE RD	CROSS KEYS AIRPORT INC	PO BOX 1649	WILDWOOD, NJ 08260	/
Moreoe Toweship	14501	15		0811- 145010000- 000150000- 00000	CROSS KEYS RD	CHOSS KEYS ABRI'ORT, INC	PO BOX 1649	WILDWOOD, NI 08260	
Moruoe Township	14501	15.01		0811- 145010000- 000150001- 00000	N TUCKAHOE RD	SCHLACTER, JAMES	1900 TUCKAHOE RD	WILLIAMSTOWN, HESSO [IA	

County Highways

Comcast Cable Co.

County Planning Departmen

<u>List of Utilities</u> Monroe Township, Gloucester Co

State Highways

Atin.: Highway Inspector
NJ Department of Transportation
One Executive Campus
Route 70 West

Monroe Municipal Utilities Authorit

Williamstown, NJ 08094 856-629-1444

Atlantic City Electric Joseph B. Riding, Mgr. 5100 Harding Hwy. Mays Landing, NJ 08330 1,800-642-3780

100 Harding Rwy.
1800-642-3780

Verizon New Jersey
140 Broad Street

Public Service Electric and Gas Compan

Manager – Corporate Properties 80 Park Plaza, T68 Newark, NI 07102

PLANNING BOARD SECRETARY

PLANNING BOARD ENVIRONMENTAL ENGINEER

I HEREBY CERTIFY THAT THE ENGINEERING CONDITIONS IMPOSED ON THIS APPLICATION FOR FINAL SITE PLAN APPROVAL HAVE BEEN MET.

PLANNING BOARD ENGINEER DATE

PLANNING BOARD PLANNER DATE

"I HEREBY CERTIFY THAT I AM THE OWNER AND APPLICANT OF RECORD

NNER/APPLICANT DATE

SITE PLANS


FOR

CROSS KEYS AIRPORT

PLATE 143, BLOCK 14301, LOT 2

SITUATED IN THE:

TOWNSHIP OF MONROE, GLOUCESTER COUNTY, NEW JERSEY

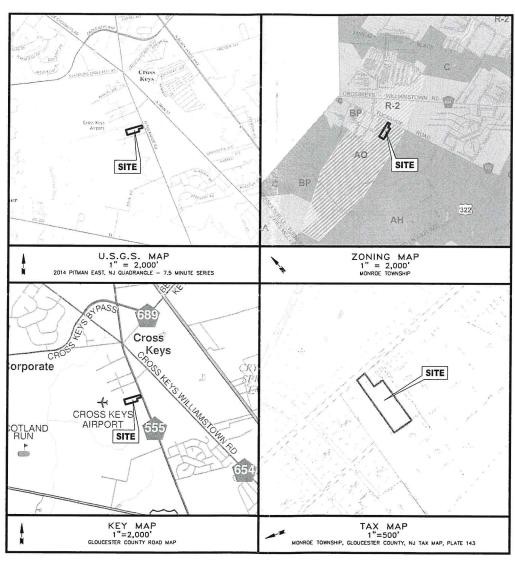

INDEX OF SHEETS

SHEET NO.	DESCRIPTION	ORIGINAL DATE	REVISION DATE
1	COVER SHEET	MAY 19, 2020	
2	SITE PLAN	MAY 19, 2020	
3	GRADING PLAN	MAY 19, 2020	
4	LIGHTING PLAN	MAY 19, 2020	-
5	SOIL EROSION AND SEDIMENT CONTROL PLAN	MAY 19, 2020	
6	SOIL EROSION AND SEDIMENT CONTROL DETAILS	MAY 19, 2020	
7	SOIL COMPACTION MITIGATION PLAN	MAY 19, 2020	-
8	SITE CONSTRUCTION DETAILS	MAY 19, 2020	-

LIST OF PERMITS AND APPROVALS

AGENCY
MONROE TOWNSHIP PLANNING BOARD
GLOUCESTER COUNTY PLANNING BOARD
GLOUCESTER COUNTY SOIL CONSERVATION DISTRICT

STATUS

SITE STATISTICS

OWNERARPLICANT:

CROSS KEYS ARPORT
PO BOX 1468
WILDWOOD, NEW VERSEY 0260
WILDWOOD, NEW VERSEY 0260

TRACT IDENTRICATION:

PARE 45, BOOX 1400, LOT 2
1531 N. TUXANDE BOAD,
VOIRGE TOWNSHIP
GLOUCESTER COUNTY, NEW JERSEY

TRACT ZONING:

BUSNESS PARK DISTRICT (BP)
WITH AIRPORT OVERLAY (AD)

TRACT AREA:
168 J88 SF (1 87 ACRESS)

EUSTING USE:
ARROANE STORAGE

PROPOSED USE:
ARROANE STORAGE

BULK STANDARDS: NONRESIDENTIAL ZONING DISTRICT (BP)

The state of the s	. (2.)		
<u>гтем</u>	REQUIRED	PROPOSED	STATUS
MINIMUM LOT AREA	20 000 SF	168,388 SF	CONFORMS
MINIMUM FRONT YARD	40 FT	205.84 FT	CONFORMS
MINIMUM LOT FRONTAGE	100 FT	123.28 FT	CONFORMS
MINIMUM SIDE YARD	20 FT	10 FT (PROP. HANGAR)	VARIANCE
		0 FT (EXIST. HANGAR)	EXISTING CONDITION
		2.19 FT (EXIST SHED)	EXISTING CONDITION
MINIMUM REAR YARD	35 FT	5.16 FT (SHED)	EXISTING CONDITION
		5.67 FT (QUONSET HUT)	EXISTING CONDITION
MAX, LOT COVERAGE	75%	51%	CONFORMS
	000	20220	

STORMWATER MANAGEME

HE PROJECT DISTURBS 0.37 ACRES WHICH IS LESS THAN 1 ACRE OF LAND AND CREATES 0.06 CRES OF ADDITIONAL IMPERIOUS COVERAGE WHICH IS LESS THAN 114 ACRES OF NEW MPERIOUS COVERAGE AND IS THEREFORE CONSIDERED A MINOR DEVELOPMENT AND NEW PREVIOUS COVERAGE AND IS THEREFORE CONSIDERED A MINOR DEVELOPMENT AND NEW

PARKING:

THE PROPOSED HANGAR IS FOR COVERED AIRPLANE STORAGE, NO ADDITIONAL PARKING IS PROPOSED.

VARIANCES REQUESTED:

TO PERMIT 10 FT SIDE YARD WHERE 20 FT IS REQUIRED.

WAIVERS:

175-71. A(3)(B) - PROVIDING CONTOURS 200 FT BEYOND THE PROPERTY

NOTES

- . SURVEY AND TOPOGRAPHY AS TAKEN FROM PLAN ENTITLED PLAN OF SURVEY, EXISTING CONDITIONS LOT 2. BLOCK 1430.) PLATE 143, PREPARED BY ZENITH/NADIR SURVEY, DATEO OCTOGER 21, 2019, FILE NUMBER SCETS31T.
- THE OWNER OR HIS REPRESENTATIVE IS TO DESIGNATE AN INDIVIDUAL RESPONSIBLE FOR CONSTRUCTION SITE SAFETY DURING THE COURSE OF SITE IMPROVEMENTS PURSUANT TO NJAC. 522-21 (c) OF THE N.J. UNIFORM CONSTRUCTION CODE AND CR 19:8-3-21 (f) (GSHA COMPETENT PERSON).

COVER SHEET

SITE PLANS
CROSS KEYS AIRPORT
PLATE 143, BLOCK 14301, LOT 2
1531 N. TUCKAHOE ROAD
STUATED IN THE
TOWNSHIP OF MONROE
COUNTY OF GLOUCESTER, STATE OF NEW JERSEY

SITE CIVIL ENGINEERING


213 CHERRY TREE COURT FRANKLINVILLE, NEW JERSEY 08322 (656) 885 - 8679 FAX (585) 513 - 5594 N.J. CERTIFICATE OF AUTHORIZATION No. GA28188600


				FILE NUMBER 2019-729	
		1		CHECKED BY: WG	
				DRAWN BY: JL	
REV.	DATE	DESCRIPTION	BY	SCALE: AS SHOWN	


APPLICATION # _


William P. St. Low	06/19/20
WILLIAM P. GILMORE, P.E.	DATE
NEW JERSEY PROFESSIONAL ENGINEER NO. 24GE04783100	

DATE: MAY 19, 2020 SHEET 1 O

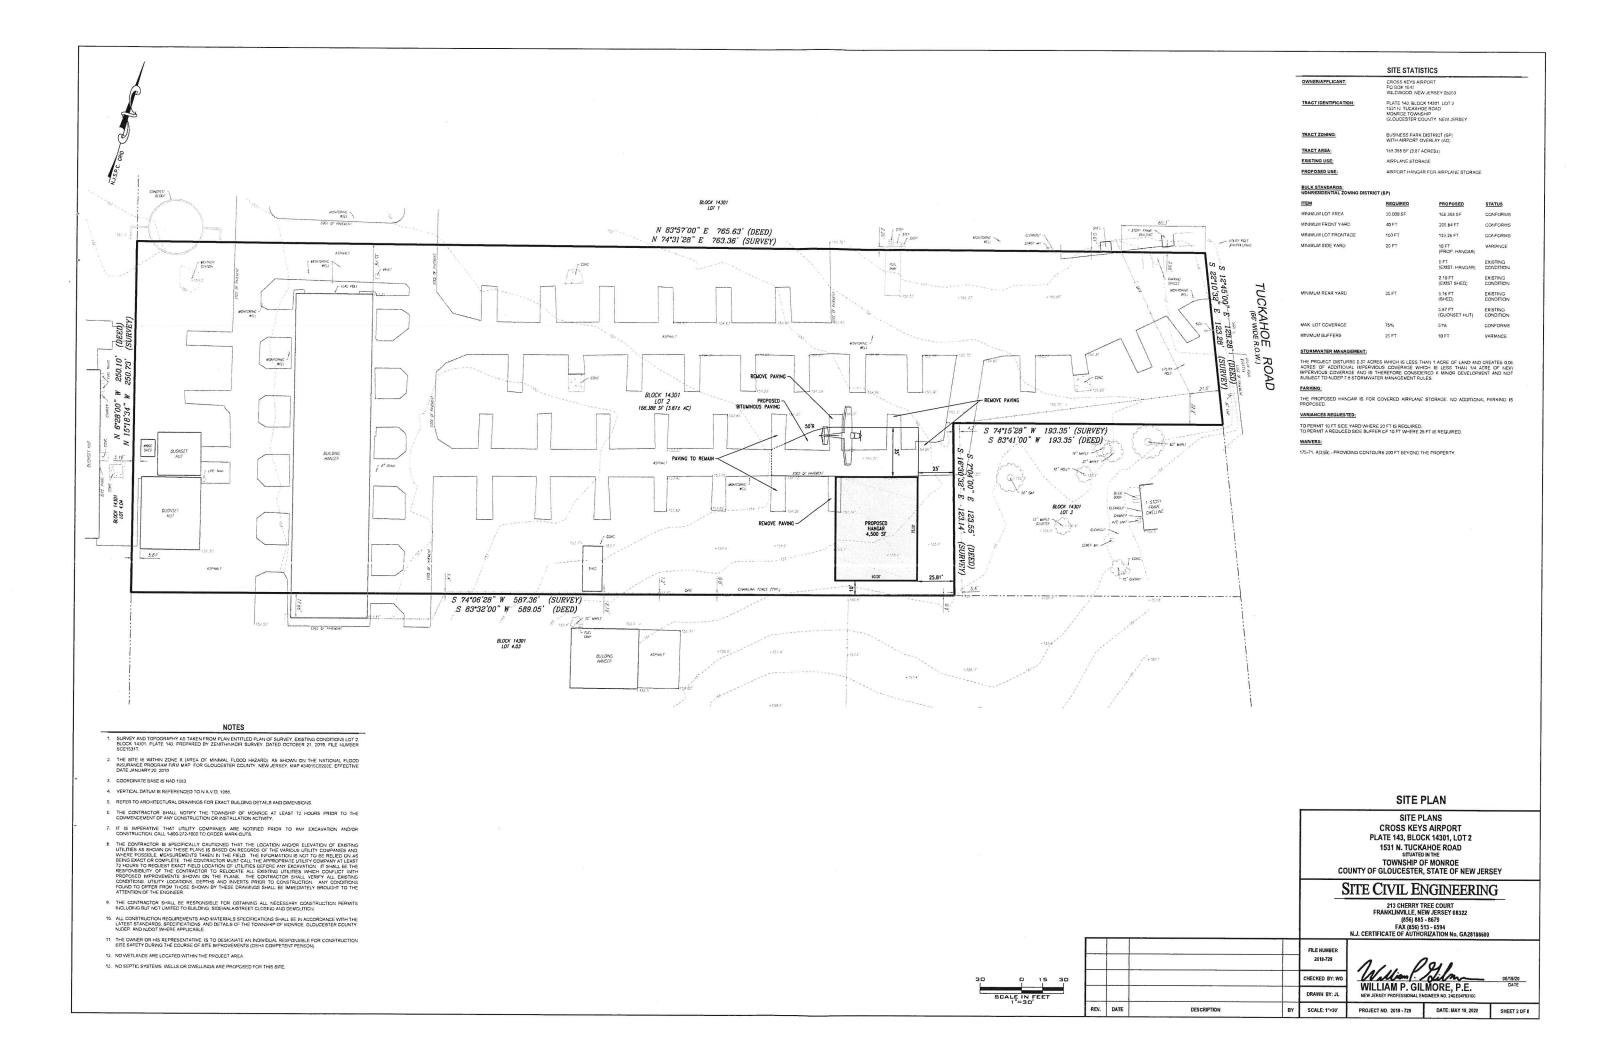

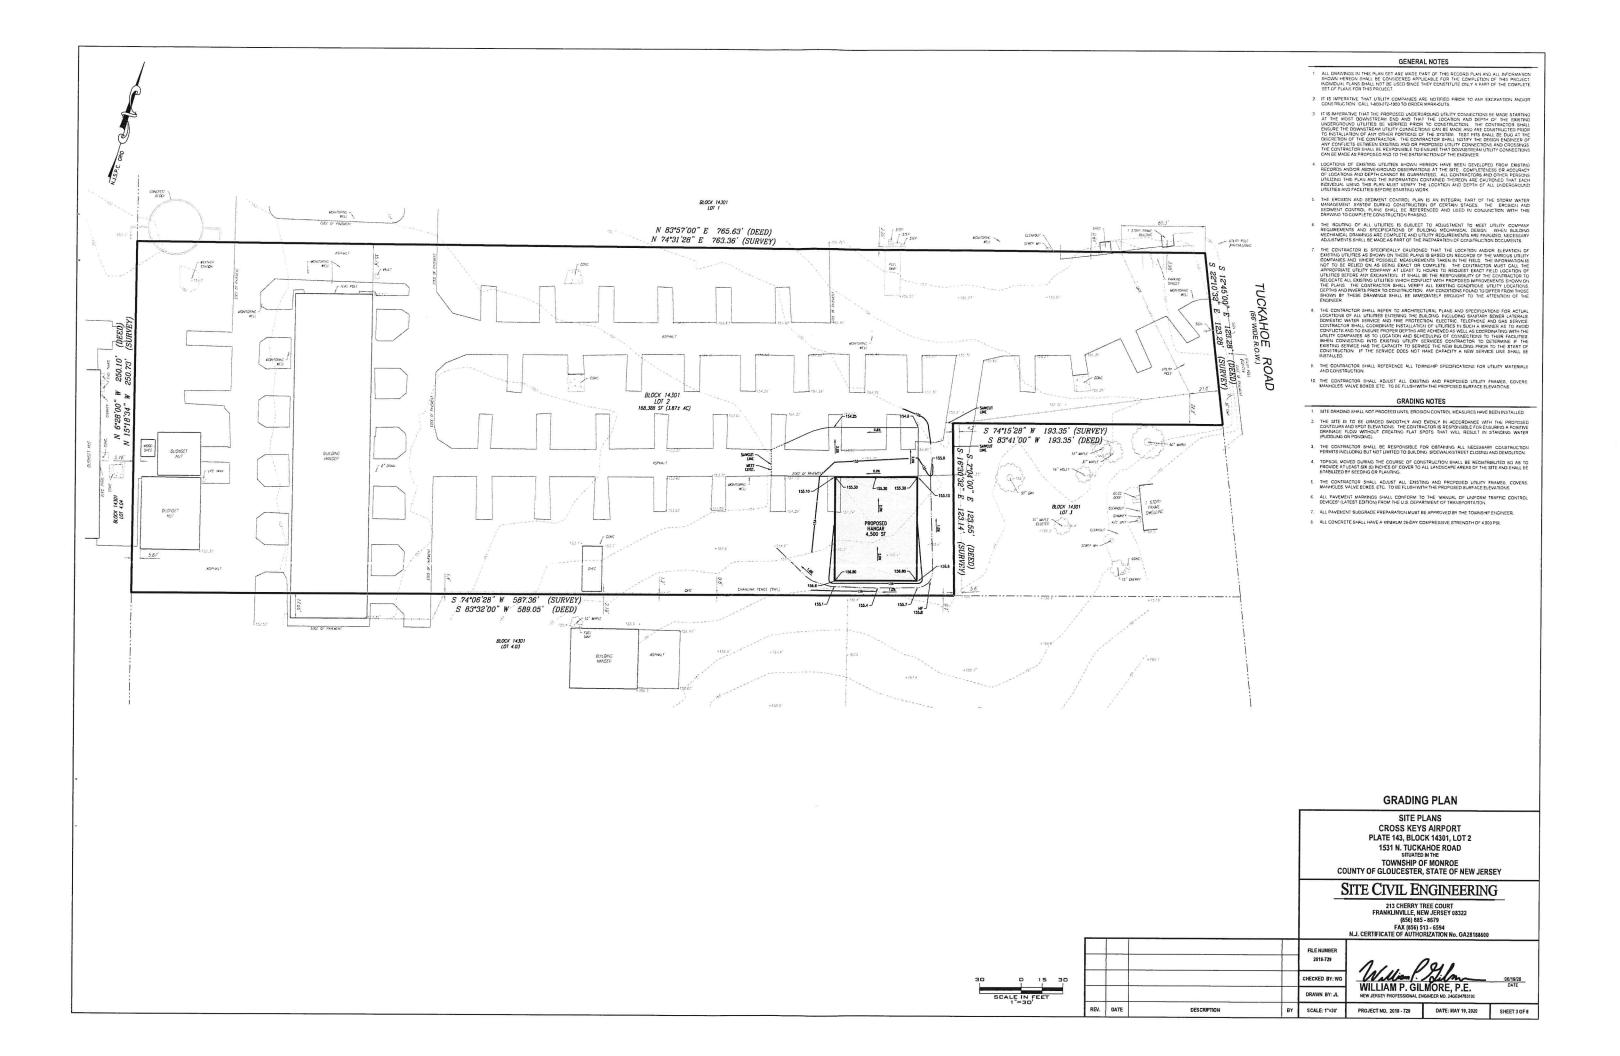

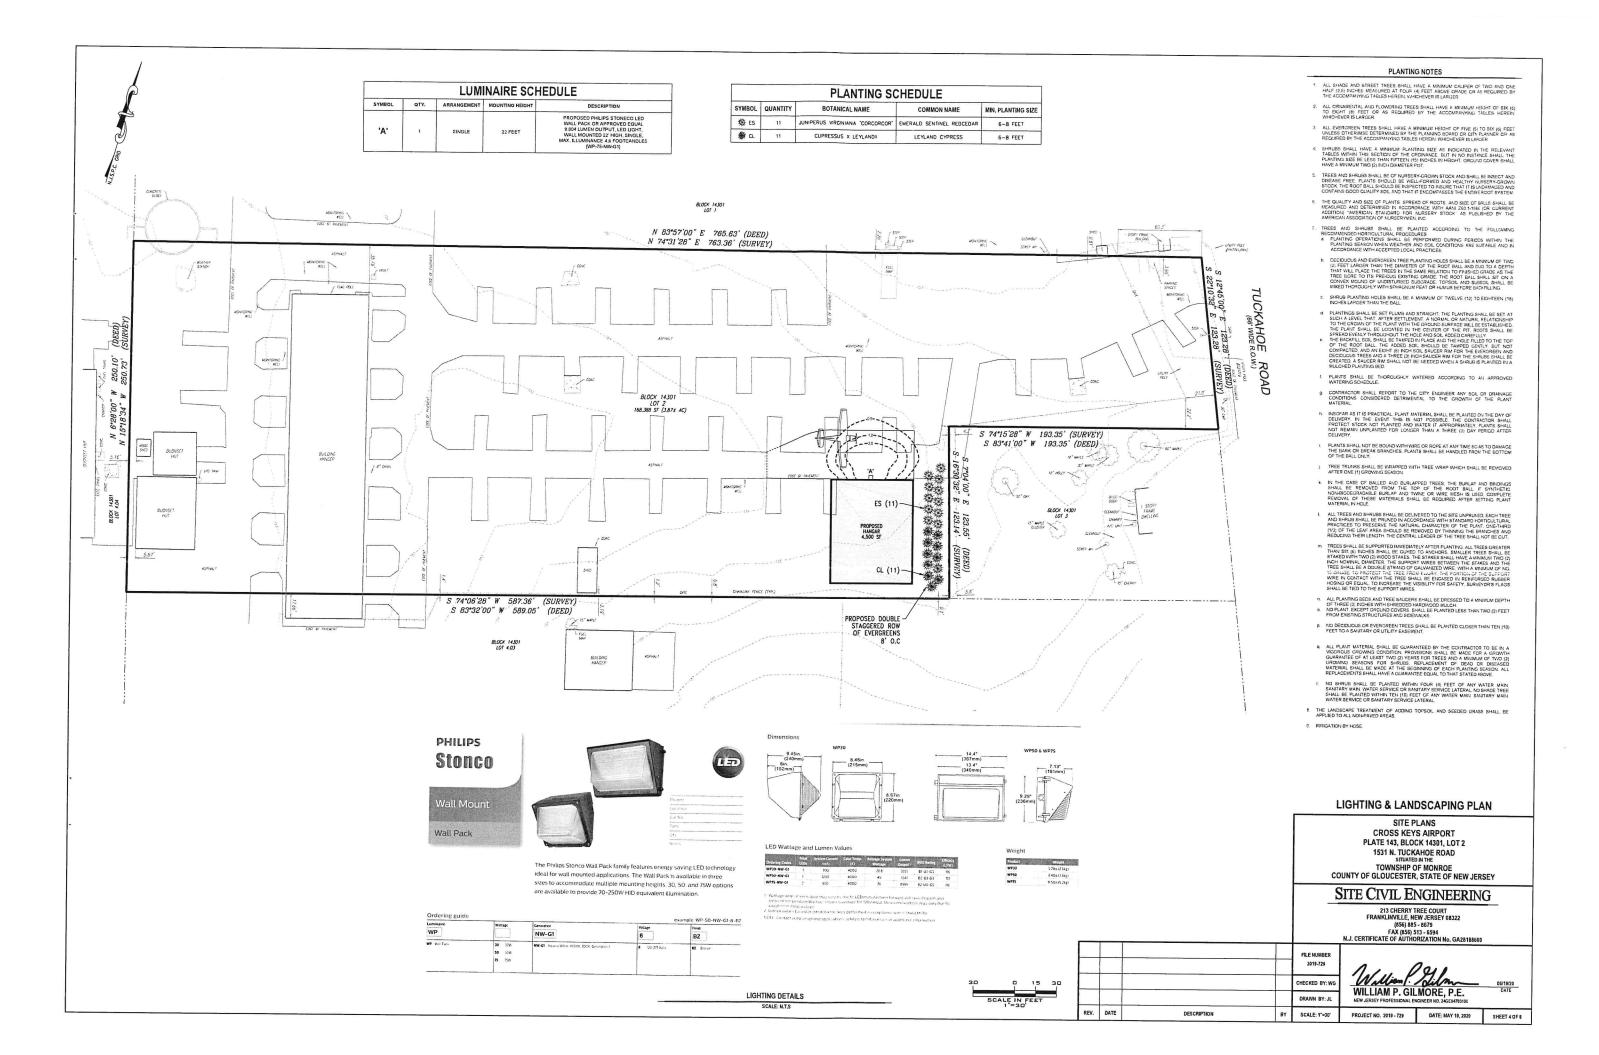

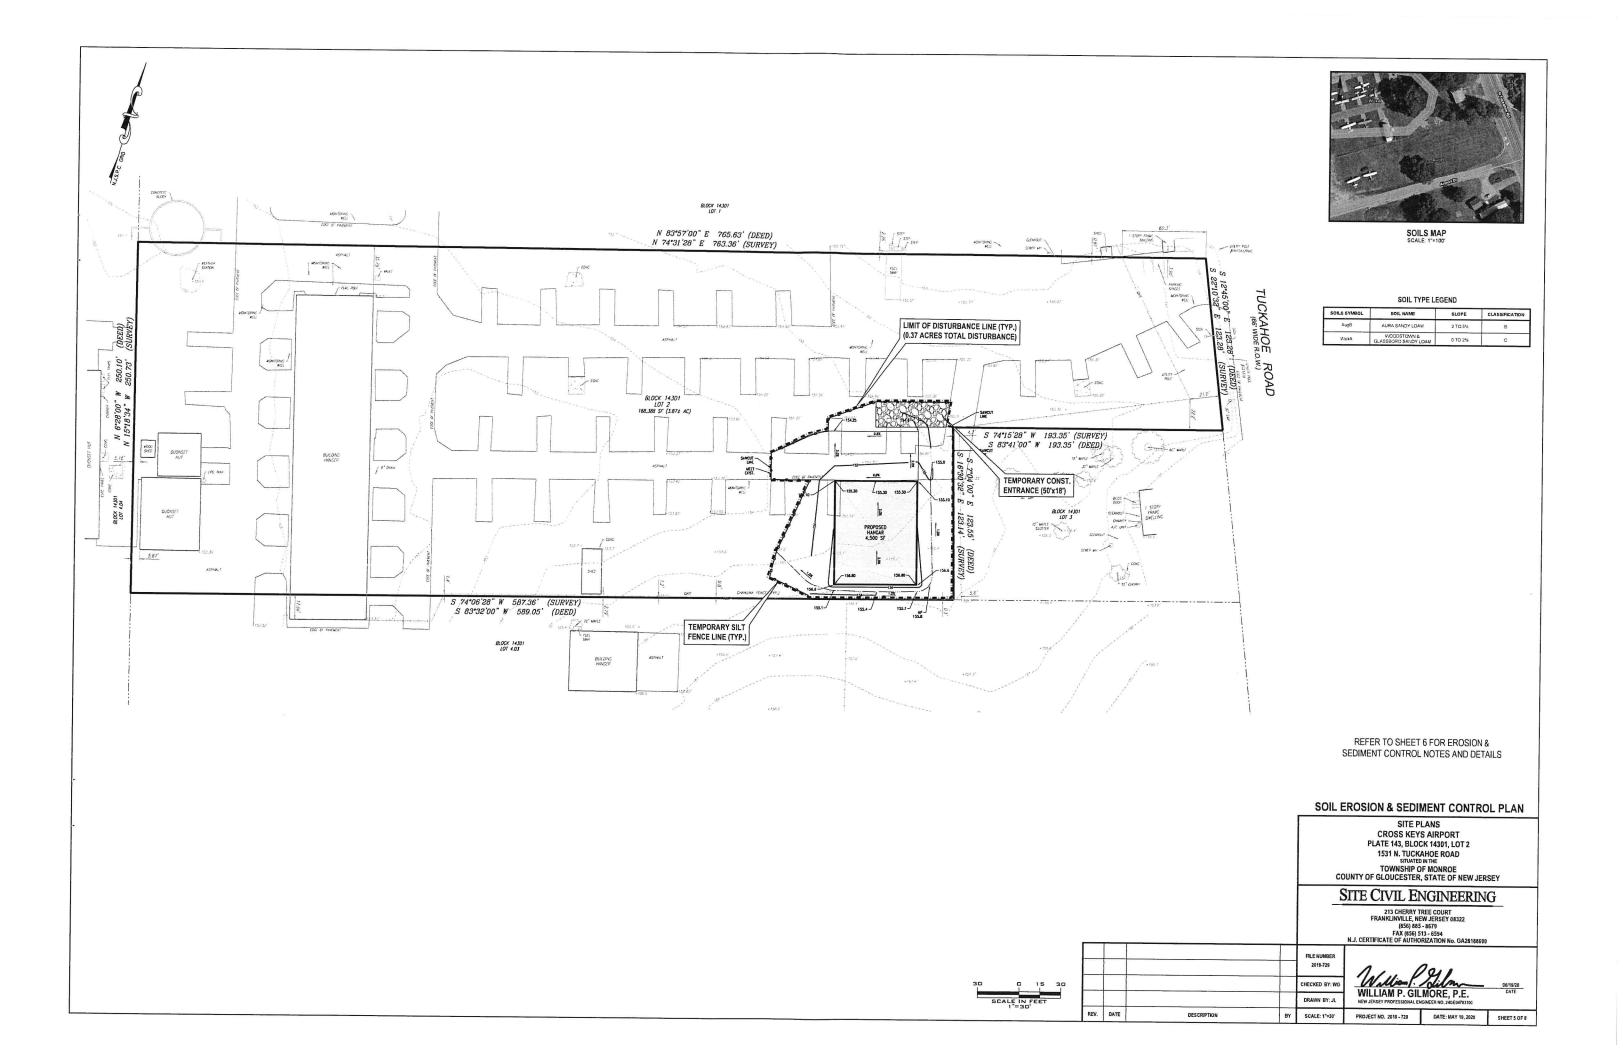

SEEDING NOTES

- TOPSOIL STRIPPING AND STOCKPILING
 FIELD EXPLORATION SHOULD BE WIDE TO DETERMINE WHETHER QUANTITY AND/OR QUALITY OF
 SURFACE SOIL, JESTIFES STRIPPING,
 STRUCTURE OR PRE-ENSITING USE.
 STRUCTURE OR PRE-ENSITING USE.
 C STOCKPILES EMOULD BE LOCATED SO AS NOT TO GISTRUCT NATURAL DRAPINGS OR CAUSE
 OFF-SITE ENVIRONMENTAL DAMAGE AND SHALL BE DELINEATED ON THE CERTIFED SOIL
 BROSION AND SEDIMENT CONTROL, PLAY AND BE CONSTRUCTED IN ACCORDANCE WITH THE

 D STOCKPILES SHOULD BE TEMPORARILY STABILIZED ACCORDING TO THE STANDARDS.

- 2. SITE PREPARATION.
 A BISTAL EROSEN CONTROL MEAGURES AND FACILITIES SUCH AS SILT FENCE DIVERSIONS.
 SEDIMENT BASINS AND CHARKEL STRABLEATION.
 B CRADE AS RECEDE AND FERSILE TO FEMILIT THE USE OF CONVENTIONAL EQUIPMENT FOR
 SECREED PREPARATION. SECOND, WILCH APPLICATION, TACKING, AND MAINTENIAGE. ALL
 CRADINGS SHOULD BE DOING HACCOPPAINES WITH THE STRANGANT FOR LIND CRADING. 194.

- SEEDING
 A. A SELECT A SEED MIXTURE APPROVED BY THE CAMBEN COUNTY SCD
 B. A APPLY SEED UNFOWNLY BY HAND CYCLOUGS DROP SEEDER DRUL OUTPACKER OF
 B. A APPLY SEED UNFOWNLY BY HAND CYCLOUGS DROP SEEDER DRUL OUTPACKER OF
 B. A APPLY SEED UNFOWNLY BY HAND CYCLOUGS DROP SEEDER DRUL OUTPACKER OF
 CONCENTIONAL APPLICATIONS ARE NOT FERSIBLE. HYDROSSEEDING, SHALL BE A TWOSTEP
 FROCESS BULLOT SHALL NOT BE MIXED WITH THE SEED. THE SEED MUST BE APPLIED FIRST TO
 ASSURE PROCEEDS SEED TO SOIL CONTRACT. THE HYDROVILLOH BY THEY BY RAYCO OVER THE
 CASHIELD TO SEED TO SOIL CONTRACT. THE HYDROVILLOH BY THEY BY AND AS A SEPTION
 CONTRACT OF THE SEED TO SOIL CONTRACT THE HYDROVILLOH BY THEY SEED AND AS A
 CONTRACT OF THE SEED TO SOIL CONTRACT SEED THE SEED THE SEED THE SEED THE SEED TO SEED THE SEED

CONSERVATION

A UNROTTED STRAIN HAY FREE OF SEEDS OR SALT MAY IS REQUIRED ON ALL SEEDING AT A RATE OF 15 TO 2 TONSAGRE. (FO TO 50 LES. flow) SQUARE FEET), EXCEPT WHERE A CRIMMER IS USED INSTEAD OF A LIQUID WILD-HENCER THEN THE RATE OF A PRILIZATION IS 3 TONS FREE ACRE.

B WILD-MAYORING SHOULD BE ACCOMPLISHED IMMEDIATELY AFTER PLACEMENT TO IMMINUE LOSS QUE TO WIND OR WATER. THIS MAY BE DONE ACCORDING TO THE FOLLOWING WETHOUS WOOD OR WATER. THIS MAY BE DONE ACCORDING TO THE FOLLOWING WETHOUS WOOD OR WATER. THE SAME OF THE CONTINUE WILD-HERT THE CONTINUE SECTION OF THE CONTINUE WILD-HERT THIS ARM SECTION OF SECTION.

• CRIMMING REQUIRES A HIGHER MULCH RATE IS TONSACRE;

NOTES

• CRIMMING REQUIRES A HIGHER MULCH RATE IS TONSACRE;

1.500 CALLION TAM OF HYDROULD-OLD CONTINUE TO SETS WITH THE CONTINUE THE THIN AND SECTION.

**ISSUE CALLION TAM OF HYDROULD-OLD CONTINUE TO SETS WITH THE CONTINUE THE THIN AND SECTION.

**ISSUE CALLION TAM OF HYDROULD-OLD CONTINUE THE SETS WITH THE CONTINUE THE THIN AND SECTION.

**PEARS NOTE THE COLLINY OF PERMANENT WESTERN TO TAKE A STATE AND SECTION.

**REDUINED WHEN A REPORT OF COMPLIANCE IS REQUISITED PRIOR TO A CATUAL OR SECTION.

**REDUINED WHEN A REPORT OF COMPLIANCE IS REQUISITED PRIOR TO A CATUAL OR CATUAL OR SETS WITH THE CONTINUE TO COMPLIANCE.

**REDUINED WHEN A REPORT OF COMPLIANCE IS REQUISITED PRIOR TO A CATUAL OR C COMPLIANCE FROM THE DISTRICT THESE RATES ARREY TO ALL METHOR ESTABLISHING PERMANERTY COGETATION MEANS SOM EVENLY DISTRIBUTED VEGETHE SEEDED SPECIES) AND MOWED ONCE.)

TEMPORARY SEEDING MIXES
MIX EARLY SPRINGLATE SUMMER TO EARLY FALL
100W PERENNIAL RYEGRASS.
RATE 100 LBS/AGRE

MIX MID-SUMMER 40% PEARL MILLET 40% MILLET (GERMAN OR HUNGARIAN) 20% WEEPING LOVEGRASS RATE: 100 LBS/ACRE

7. RECOMMENDED PERMANENT SEEDING MIXES

OPTIMUM SECOND DATES FEBRUARY 15 TO MARCH 30 AND AUGUST 15 TO OCTOBER 30 LAVAS - FATE 200 LESAGE.

LAVAS - FATE 200 LESAGE.

TO THE TO THE SECOND SEC

MIX LAWNS - LOW MAINTENANCE DROUGHTY & HEAVY TRAFFIC 80% TALL FESCUE TURE TYPE (LOW GROWING VARIETIES)*# 10% PERENNIAL RYEGRASS (LOW GROWING VARIETIES)*

MIX. SHADE 65% HARD, CHEWINGS, OR CREEPING RED FESCUE-20% KENTUCKY BLUEGRASS 15% PERENNIAL RYEGRASS

MIK LAWNS – QUALITY SUN AND SHADE 20% PERENNIAL RYEGRASS 30% CHEWNISS FESCUE 35% CREEPING RED FESCUE 15% KENTUCKY BLUEGRASS

("INCLUDE AT LEAST THREE VARIETIES IN VIX) + USE THE ABOVE MIX FOR INFREQUENT MOMING FOR A REGULAR #EXCLUDE K-31; MOMING REGINE SUBSTITUTE ROUGH BLUEGRASS AND/OR TALL FESCUE FOR THE FLAT PEA. CONSERVATION PLANTINGS.

PERMANENT SEED MIXTURE

OPTIMUM SEEDING DATES FEBRUARY 15 TO MARCH 30 AND AUGUST 15 TO OCTOBER 30

HYDROSEED AREA MUST RECEIVE MULCH AND TACKIFIER.

SEED MIX FOR LAWNS 70% TURF TYPE TALL FESCUE 20% PERENNIAL RYE 10% KENTUCKY BLUE GRASS

CONSTRUCTION SEQUENCE

- 1. MOBILIZATION, 1 WEEK
- 2. CONSTRUCT TEMPORARY SOIL EROSION AND SEDIMENT CONTROL FACILITIES. 3 DAYS
- 3. DEMO, CLEAR AND ROUGH GRADE SITE. 1 WEEK
- 4. INSTALL UTILITIES, 1 WEEK
- 5 CONSTRUCT HANGAR, 3 WEEKS
- 7. ESTABLISH PERMANENT COVER AND LANDSCAPING. 1 WEEK
- 8. COLLECT SILT AND SEDIMENT AND REMOVE FROM SITE. 1 WEEK. 9. REMOVE SOIL EROSION & SEDIMENT CONTROL MEASURES. 3 DAYS.

ESTIMATED TOTAL TIME OF CONSTRUCTION 3 MONTHS

TOPSOIL NOTES

- 1. TOPSOIL SHOULD BE FRIARLE LOANY. FREE OF DEBRIS ORJECTIONABLE WEEDS AND STONES AND CONTAIN NO TOXIC SUBSTANCE OR ADVERSE GHEWICAL OR PHYSICAL CONDITION THAT WAY BE HARWELT TO RAILT GROWN'TH SOURCE SATES SHOULD NOT BE EXCESSIVE (CONDITION THAT WAY BE THAN 0.5 WILLIMMOS PER CENTIMETER, MORE THAN 0.5 WILLIMMOS WAY DESCATE SEED, MOSS AND ADVERSELY WIPACT GROWN'T, TOPSOIL HAULED IN FROM OFFSTE SHOULD HAVE A MINIMUM ORGANIC MATTER CONTENT OF 2.75 PERCENT. ORGANIC MATTER CONTENT MAY BE RAISED BY ADDITIVES.

STRIPPING AND STOCKPILING

- A. FIELD EXPLORATION SHOULD BE MADE TO DETERMINE WHETHER QUANTITY AND OR QUALITY OF SURFACE SOIL JUSTIFIES STRIPPING.
- B. STRIPPING SHOULD BE CONFINED TO THE IMMEDIATE CONSTRUCTION AREA.
- D. A 4-6 INCH STRIPPING DEPTH IS COMMON, BUT MAY VARY DEPENDING ON THE PARTICULAR SOIL.
- E. STOCKPILES OF TOPSOIL SHOULD BE SITUATED SO AS NOT TO OBSTRUCT NATURAL DRAINAGE OR CAUSE OFFSITE ENVIRONMENTAL DAMAGE.
- F. STOCKPILES SHOULD BE VEGETATED IN ACCORDANCE WITH STANDARDS PREVIOUSLY DESCRIBED HEREIN, SEE STANDARDS FOR PERMANENT (PG. 4-1) OR TEMPORARY (FG.7-1) VEGETATIVE COVER FOR SOLI STANDLATION WEEDS SHOULD NOT BE ALCOWED TO GROW DO STOCKPILES.

- A GRADE AT THE ONSET OF THE OPTIMAL SEEDING PERIOD SO AS TO MINIMIZE THE DURATION AND AREA OF EXPOSURE OF DISTURBED SOIL TO EROSION. IMMEDIATELY PROCEED TO ESTABLISH VEGETATIVE COVER IN ACCORDANCE WITH THE SPECIFIED SEED MINTURE. TIME IS OF THE ESSENCE.
- B. GRADE AS NEEDED AND FEASIBLE TO PERMIT THE USE OF CONVENTIONAL EQUIPMENT FOR SEEDBED PREPARATION SEEDING, MULCH APPLICATION AND ANCHORING AND MAINTENANCE. SEE THE STANDARD FOR LAND GRADING PG. 19-1.
- IMMEDIATELY PRIOR TO TOPSOLUNG, THE SURFACE SHOULD BE SCARFIED 6: TO 12" WHERE THERE
 HAS BEEN SOIL COMPACTION. THIS WILL HELP INSURE A GOOD BOND BETWEEN THE TOPSOIL AND
 SUPSOIL. THIS PRACTICE IS PERVISIBLE FOR Y WHERE THERE IS NO DAMISED TO LANGER/BRIDING
 UTILITIES (CREASE, MRIGATION SYSTEMS ETC.).
- E. EMPLOY NEEDED EROSION CONTROL PRACTICES SUCH AS DIVERSIONS, GRADE STABILIZATION STRUCTURES, CHANNEL STABILIZATION MEASURES, SEDIMENTATION BASINS AND WATERWAYS, SEE STANDARDS 11 THROUGH 42.

APPLYING TOPSOIL

- TOPSOIL SHOULD BE HANDLED ONLY WHEN IT IS DRY ENOUGH TO WORK WITHOUT DAMAGING SOIL STRUCTURE, I.E., LESS THAN FIELD CAPACITY.
- 6. A UNIFORM APPLICATION TO A DEPTH OF 5 INCHES (UNSETTLED) IS RECOMMENDED. SOILS WITH A PH OF 40 OR LESS OR CONTAINING IRON SULFIDE SHALL BE COVERED WITH A MINIMUM DEPTH OF 12 INCHES OF SOIL HAVING A PH OF 50 OR MORE. IN ACCORDANCE WITH THE STANDARD FOR MAINGEIGENT OF HIGH ACID PRODUCING SOIL.

STANDARDS FOR DUST CONTROL

DEFINITION, THE CONTROL OF DUST ON CONSTRUCTION SITES AND ROADS.

PURPOSE: TO PREVENT BLOWING AND MOVEMENT OF DUST FROM EXPOSED SOIL SURFACES, REDUCED ON-SITE AND OFF-SITE DAMAGE AND HEALTH HAZARDS, AND IMPROVE TRAFFIC SAFETY.

CONDITION WHERE PRACTICE APPLIES THIS PRACTICE IS APPLICABLE TO AREAS SUBJECT TO DUST BLOWING AND MOVEMENT WHERE ON-SITE AND OPT-SITE DAMAGE IS LIKELY WITHOUT TREATMENT. CONSULT WITH LOCAL MUNICIPAL ORDINANCES ON ANY REST

WHITE DULITY DE-MACENETI SEDIENTS DEFORTED AS 'DEST' ARE OFTEN FINE COLDIDA: MATERIAL WHICH IS ENTEREDLY DIFFICULT OF REDUCE FROM WATER ONCE IT BECOMES SUSPENDED USE OF THE STANDARD WILL HELF OF DUTING HE CHECK FROM THE CONTRIBUTION OF STANDARD WILL HELF OF DUTING HE CHECK WATER DESCRIPTION OF STANDARD WILL HELF OF DUTING HE CHECK WATER RESOURCES CONSTRUCTION STEELS AND SUSSECURATE BECOMES OF THE CHECK FROM THE CHECK FROM

MULCHES -SEE STANDARD OF STABILIZATION WITH MULCHES ONLY, PG. 5-1


VEGETATIVE COVER-SEE STANDARD FOR TEMPORARY VEGETATIVE COVER, PG. 7-1, PERMANENT VEGETATIVE COVER FOR SOIL STABILIZATION PG. 4-1, AND PERMANENT STABILIZATION WITH SOD, PG. 6-1 SPRAY-ON ADHESIVES -ON MINERAL SOILS (NOT EFFECTIVE ON MUCK SOILS), KEEP TRAFFIC OFF THESE AREAS.


-6" TH. CRUSHED ANGULAR STONE CONFORMING TO ASTM C-33, SIZE No. 2 or 3 50' LONG x 30' MDE PERCENT SLOPE OF ROADWA LENGTH OF STONE REQUIRED COARSE GRAINED SOILS FINE GRAINED SOILS
50 FEET 100 FEET

MAINTENANCE

(SEE PLAN)

TEMPORARY STABILIZED CONSTRUCTION ENTRANCE DETAIL

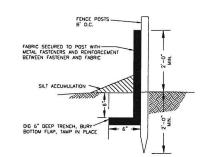

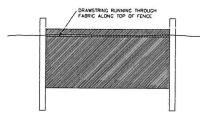

- NOTES
 1. FENCE POSTS SHALL BE HARDWOOD WITH A MINIMUM THICKNESS OF 1-1/2 INCHES.
- 2. WHERE INDICATED ON THE PLANS, SILT FENCE MAY BE REINFORCED WITH METAL WIRE FENCE. REINFORCEMENT FENCE SHALL BE AT LEAT 2 FEET HIGH AND SHALL HAVE OPENINGS NO GREATER THAN 6 INCHES WIDE.

TEMPORARY SILT FENCE DETAIL N.T.S.


SOIL EROSION & SEDIMENT CONTROL **DETAIL SHEET**


SITE PLANS **CROSS KEYS AIRPORT** PLATE 143, BLOCK 14301, LOT 2 1531 N. TUCKAHOE ROAD TOWNSHIP OF MONROE COUNTY OF GLOUCESTER, STATE OF NEW JERSEY

SITE CIVIL ENGINEERING


213 CHERRY TREE COURT FRANKLINVILLE, NEW JERSEY 08322 (856) 885 - 8679 FAX (856) 513 - 6594 N.J. CERTIFICATE OF AUTHORIZATION

					16.3. OLIVIA IGATE OF ACTIO	MEATION NO. CAZO 100000	
				FILE NUMBER 2019-729	1.1.1	241	
				CHECKED BY: WG	William .	dilm_	06/19/20 DATE
				DRAWN BY: JL	WILLIAM P. GIL NEW JERSEY PROFESSIONAL EN		
REV.	DATE	DESCRIPTION	ВҮ	SCALE: 1"=30"	PROJECT NO. 2019 - 729	DATE: MAY 19, 2020	SHEET 6 OF 8

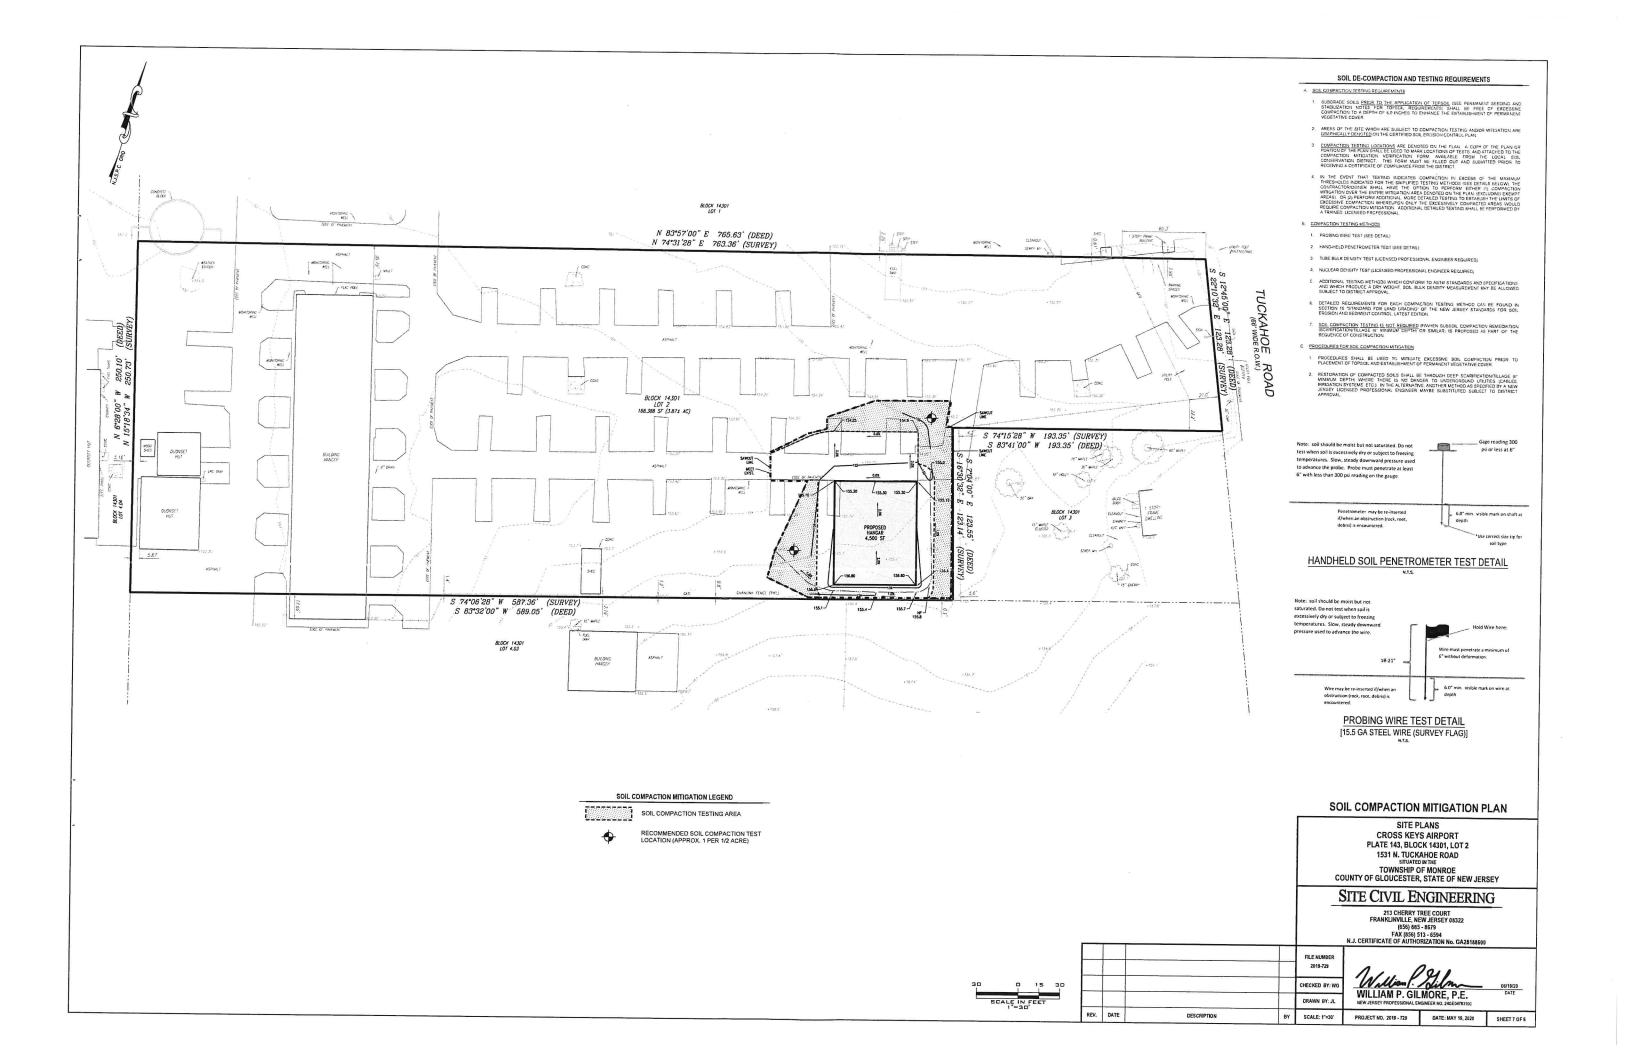


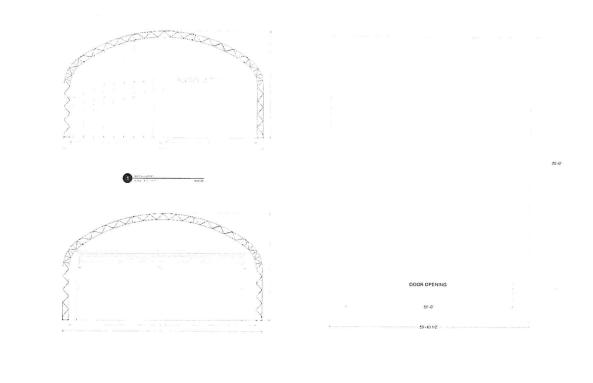

HANGAR DETAIL
N.T.S.

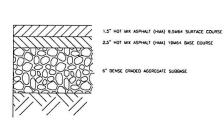

PAVEMENT SPECIFICATION DETAIL

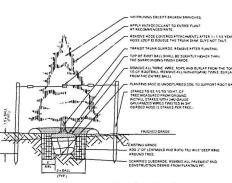

EVERGREEN TREE PLANTING DETAIL

DETAIL SHEET

SITE PLANS
CROSS KEYS AIRPORT
PLATE 143, BLOCK 14301, LOT 2
1531 N. TUCKAHOE ROAD
STATED NTE
TOWNSHIP OF MONROE
COUNTY OF GLOUCESTER, STATE OF NEW JERSEY

SITE CIVIL ENGINEERING

213 CHERRY TREE COURT FRANKLINVILLE, NEW JERSEY 08322 (856) 865 - 8679 FAX (865) 813 - 6594 N.J. CERTIFICATE OF AUTHORIZATION No. GA28188500

				ILS. SERTIFICATE OF ACTIONES, CA20100000					
				FILE NUMBER 2019-729	1.1.16				
				CHECKED BY: WG	William P. GIL	MODE DE	06/19/20 DATE		
				DRAWN BY: JL	NEW JERSEY PROFESSIONAL EX		10000041		
REV.	DATE	DESCRIPTION	BY	SCALE: AS NOTED	PROJECT NO. 2019 - 729	DATE: MAY 19, 2020	SHEET 8 OF 8		